

**PROJECT DESCRIPTION**

THE PROPOSAL IS FOR AN UNMANNED WIRELESS COMMUNICATION FACILITY CONSISTING OF THE INSTALLATION OF TWELVE (12) PANEL ANTENNAS AND ANCILLARY EQUIPMENT ON A FRAME ON AN EXISTING MONOPOLE AND THE PLACEMENT OF A SHELTER WITH A 200A SERVICE, AND A PROPOSED GENERATOR WITHIN AN EXISTING FENCED COMPOUND.

**PROJECT INFORMATION**


<b>APPLICANT:</b>	AT&T MOBILITY CORPORATION 7150 STANDARD DRIVE HANOVER, MD 21076
JURISDICTION:	CHARLES COUNTY
SITE ADDRESS:	3785 LEONARDTOWN ROAD WALDORF, MD 20602
LATITUDE:	N 38° 36' 44.69" NAD 83
LONGITUDE:	W 76° 53' 11.66" NAD 83
AMSL:	185'± AMSL
PROPERTY OWNER:	BRD OF EDUCATION OF CHARLES CO MD
TAX MAP:	0115
PARCEL:	0333
ZONING CLASS:	-
AREA OF DISTURBANCE OF ACCESS ROAD AND LEASE AREA:	3,900 S.F.



**HEATHCOTE  
TAX # 06066518  
10103463-3227**

**VICINITY MAP**

**DIRECTIONS:** FROM AT&T HANOVER OFFICE, HEAD SOUTHWEST ON STANDARD DR TOWARD PARKWAY DRIVE. TURN LEFT ONTO PARKWAY DRIVE. TAKE THE 1ST RIGHT ONTO PARK CIRCLE DRIVE. TURN LEFT ONTO COCA COLA DRIVE. TURN LEFT TO MERGE ONTO MD-100 E TOWARD GLEN BURNIE. TAKE EXIT 9A FOR MD-295 S/BALT/WASHINGTON PARKWAY TOWARD WASHINGTON S. MERGE ONTO MD-295 S. TAKE THE EXIT ONTO I-495 S/I-95 S TOWARD RICHMOND VA/ANDREWS AIR FORCE BASE. TAKE EXIT 7A-7B FOR MD-5/BRANCH AVE TOWARD SILVER HILL/WALDORF 0.1 MI 10. TAKE EXIT 7A ON THE LEFT TO MERGE ONTO MD-5 S/BRANCH AVE TOWARD WALDORF. CONTINUE TO FOLLOW MD-5 S 12.5 MI. CONTINUE ONTO US-301 S FOR 2.8 MI. TURN LEFT ONTO LEONARDTOWN ROAD. CONTINUE 1.5 MI, DESTINATION WILL BE ON THE RIGHT.

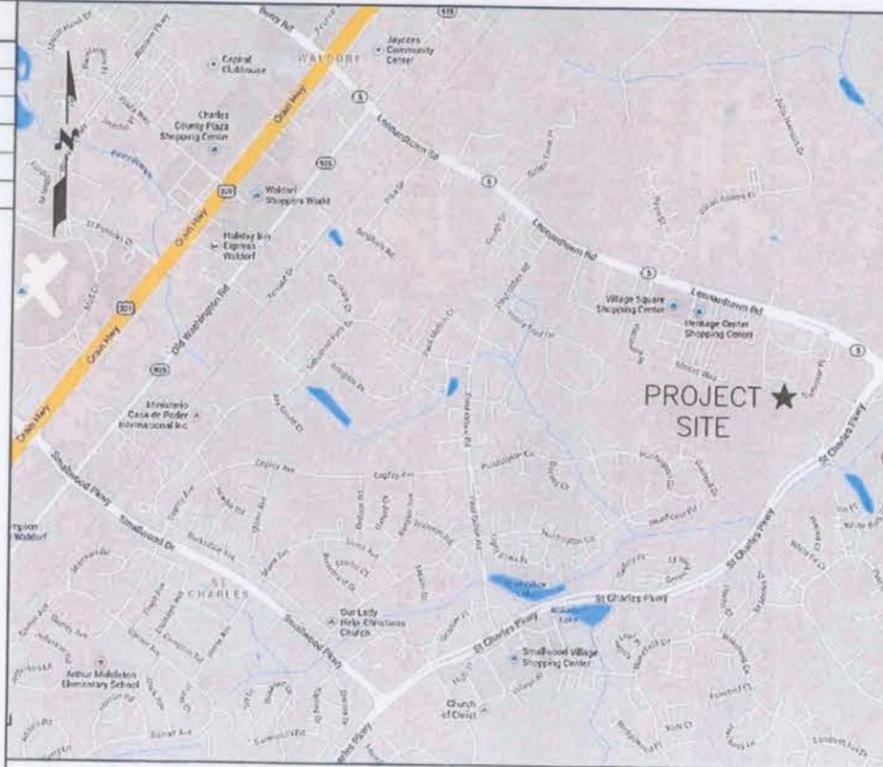

NOT TO SCALE

**GENERAL NOTES**

1. SUBCONTRACTOR'S WORK SHALL GIVE ALL NOTICES AND REGULATIONS AND LAWFUL ORDERS OF ANY PUBLIC AUTHORITY. MUNICIPAL AND UTILITY COMPANY SPECIFICATIONS, AND LOCAL AND STATE JURISDICTIONAL CODES BEARING ON THE PERFORMANCE OF THE WORK. THE WORK PERFORMED ON THE PROJECT AND THE MATERIALS INSTALLED SHALL BE IN STRICT ACCORDANCE WITH ALL APPLICABLE CODES, REGULATIONS AND ORDINANCES.
2. THE ARCHITECT/ENGINEER HAVE MADE EVERY EFFORT TO SET FORTH IN THE CONSTRUCTION AND CONTRACT DOCUMENTS THE COMPLETE SCOPE OF WORK. THE SUBCONTRACTOR BIDDING THE JOB IS NEVERTHELESS CAUTIONED THAT MINOR OMISSIONS OR ERRORS IN THE DRAWINGS AND OR SPECIFICATIONS SHALL NOT EXCUSE SAID SUBCONTRACTOR FROM COMPLETING THE PROJECT AND IMPROVEMENTS IN ACCORDANCE WITH THE INTENT OF THESE DOCUMENTS.
3. THE SUBCONTRACTOR OR BIDDER SHALL BEAR THE RESPONSIBILITY OF NOTIFYING (IN WRITING) THE AT&T REPRESENTATIVE (BECHTEL) OF ANY CONFLICTS, ERRORS OR OMISSIONS PRIOR TO THE SUBMISSION OF SUBCONTRACTOR'S PROPOSAL OR PERFORMANCE OR WORK. IN THE EVENT OF DISCREPANCIES, THE SUBCONTRACTOR SHALL PRICE THE MORE COSTLY OR EXTENSIVE WORK, UNLESS DIRECTED IN WRITING OTHERWISE.
4. THE SCOPE OF WORK SHALL INCLUDE FURNISHING ALL MATERIALS, EQUIPMENT, LABOR AND ALL OTHER MATERIALS AND LABOR DEEMED NECESSARY TO COMPLETE THE WORK/PROJECT AS DESCRIBED HEREIN.
5. THE SUBCONTRACTOR SHALL VISIT THE JOB SITE PRIOR TO THE SUBMISSION OF BIDS OR PERFORMING WORK TO FAMILIARIZE HIMSELF WITH THE FIELD CONDITIONS AND TO VERIFY THAT THE PROJECT CAN BE CONSTRUCTED IN ACCORDANCE WITH THE CONTRACT DOCUMENTS. THE SUBCONTRACTOR SHALL OBTAIN AUTHORIZATION TO PROCEED WITH CONSTRUCTION PRIOR TO DRAWINGS/CONTRACT DOCUMENTS.
6. THE SUBCONTRACTOR SHALL INSTALL ALL EQUIPMENT AND MATERIALS ACCORDING TO THE MANUFACTURER'S/VENDOR'S SPECIFICATIONS UNLESS OTHERWISE OR WHERE LOCAL CODE OR ORDINANCES TAKE PRECEDENCE.
7. THE SUBCONTRACTOR SHALL PROVIDE A FULL SET OF CONSTRUCTION DOCUMENTS AT THE SITE UPDATED WITH THE LATEST REVISIONS AND ADDENDUMS OR CLARIFICATIONS AVAILABLE FOR THE USE BY ALL PERSONNEL INVOLVED WITH THE PROJECT.
8. THE SUBCONTRACTOR SHALL SUPERVISE AND DIRECT THE PROJECT DESCRIBED HEREIN THE SUBCONTRACTOR SHALL BE SOLELY RESPONSIBLE FOR ALL THE CONSTRUCTION MEANS, METHODS, TECHNIQUES, SEQUENCES AND PROCEDURES AND FOR COORDINATING ALL PORTIONS OF THE WORK UNDER THE CONTRACT.
9. THE SUBCONTRACTOR SHALL BE RESPONSIBLE FOR OBTAINING ALL PERMITS AND INSPECTIONS WHICH MAY BE REQUIRED FOR THE WORK BY THE ARCHITECT/ENGINEER, THE STATE, COUNTY OR LOCAL GOVERNMENT AUTHORITY.
10. THE SUBCONTRACTOR SHALL MAKE NECESSARY PROVISIONS TO PROTECT EXISTING IMPROVEMENTS, EASEMENTS, PAVEMENTS, CURBING, ETC. DURING CONSTRUCTION. UPON COMPLETION OF WORK, THE SUBCONTRACTOR SHALL REPAIR ANY DAMAGE THAT MAY HAVE OCCURRED DUE TO CONSTRUCTION ON OR ABOUT THE PROPERTY.
11. THE SUBCONTRACTOR SHALL MAINTAIN THE GENERAL WORK AREA AS CLEAN AND HAZARD FREE DURING CONSTRUCTION AND DISPOSE OF ALL DIRT, DEBRIS, RUBBISH AND REMOVE EQUIPMENT NOT SPECIFIED AS REMAINING ON THE PROPERTY. PREMISES SHALL BE LEFT IN CLEAN CONDITION AND FREE FROM PAINT SPOTS, DUST, OR SMUDGES OF ANY NATURE.
12. THE SUBCONTRACTOR SHALL COMPLY WITH ALL OSHA REQUIREMENTS AS THEY APPLY TO THIS PROJECT.
13. THE SUBCONTRACTOR SHALL NOTIFY THE AT&T REPRESENTATIVE (BECHTEL) WHERE A CONFLICT OCCURS ON ANY OF THE CONTRACT DOCUMENTS. THE SUBCONTRACTOR IS NOT TO ORDER MATERIAL OR CONSTRUCT ANY PORTION OF THE WORK THAT IS IN CONFLICT UNTIL CONFLICT IS RESOLVED BY THE AT&T REPRESENTATIVE (BECHTEL).
14. THE SUBCONTRACTOR SHALL VERIFY ALL DIMENSIONS, ELEVATIONS, PROPERTY LINES, ETC. ON THE JOB.
15. BUILDING CODE: INTERNATIONAL BUILDING CODE 2009; IRC 2003 WITH LOCAL AMENDMENTS  
NATIONAL ELECTRICAL CODE: NEC 2008 WITH LOCAL AMENDMENTS  
FIRE/LIFE SAFETY CODE: NFPC 1996 WITH LOCAL AMENDMENTS.

**DRAWING INDEX**

		REV.
T1	TITLE SHEET	0
C1	ZONING MAP	0
C2	BOUNDARY SITE PLAN	0
C3	COMPOUND LAYOUT AND ELEVATION VIEW	0
C4	CONSTRUCTION DETAILS	0
C5	GENERATOR DETAILS	0

Later submittal  
**FILE COPY**

(22)



TECTONIC Engineering & Surveying Consultants P.C.  
8639 Mayland Drive, Suite 102  
Richmond, VA 23294  
Phone: (804) 217-8504  
Fax: (804) 270-0593  
www.tectonicengineering.com

**HEATHCOTE  
CROWN 881050  
10103463-3227  
3785 LEONARDTOWN ROAD  
WALDORF, MD 20602**




AT&T MOBILITY CORP.  
7150 STANDARD DRIVE  
HANOVER, MD 21076

NO.	DATE	REVISIONS	BY	CHK	APP'D
D	4/8/14	PER COMMENTS		CAL	PSM
C	11/13/13	REVISED ACCESS ROAD		JDD	PSM
B	10/29/13	SURVEY ADDED		JDD	PSM
A	10/15/13	FOR REVIEW		JDD	PSM
SCALE: AS SHOWN		DESIGNED BY: PSM	DRAWN BY: CAL		



TITLE SHEET		
PROJECT NUMBER: 10103463-3227		
JOB NUMBER	DRAWING NUMBER	REV
6620.HEATHCOTE	T1	0

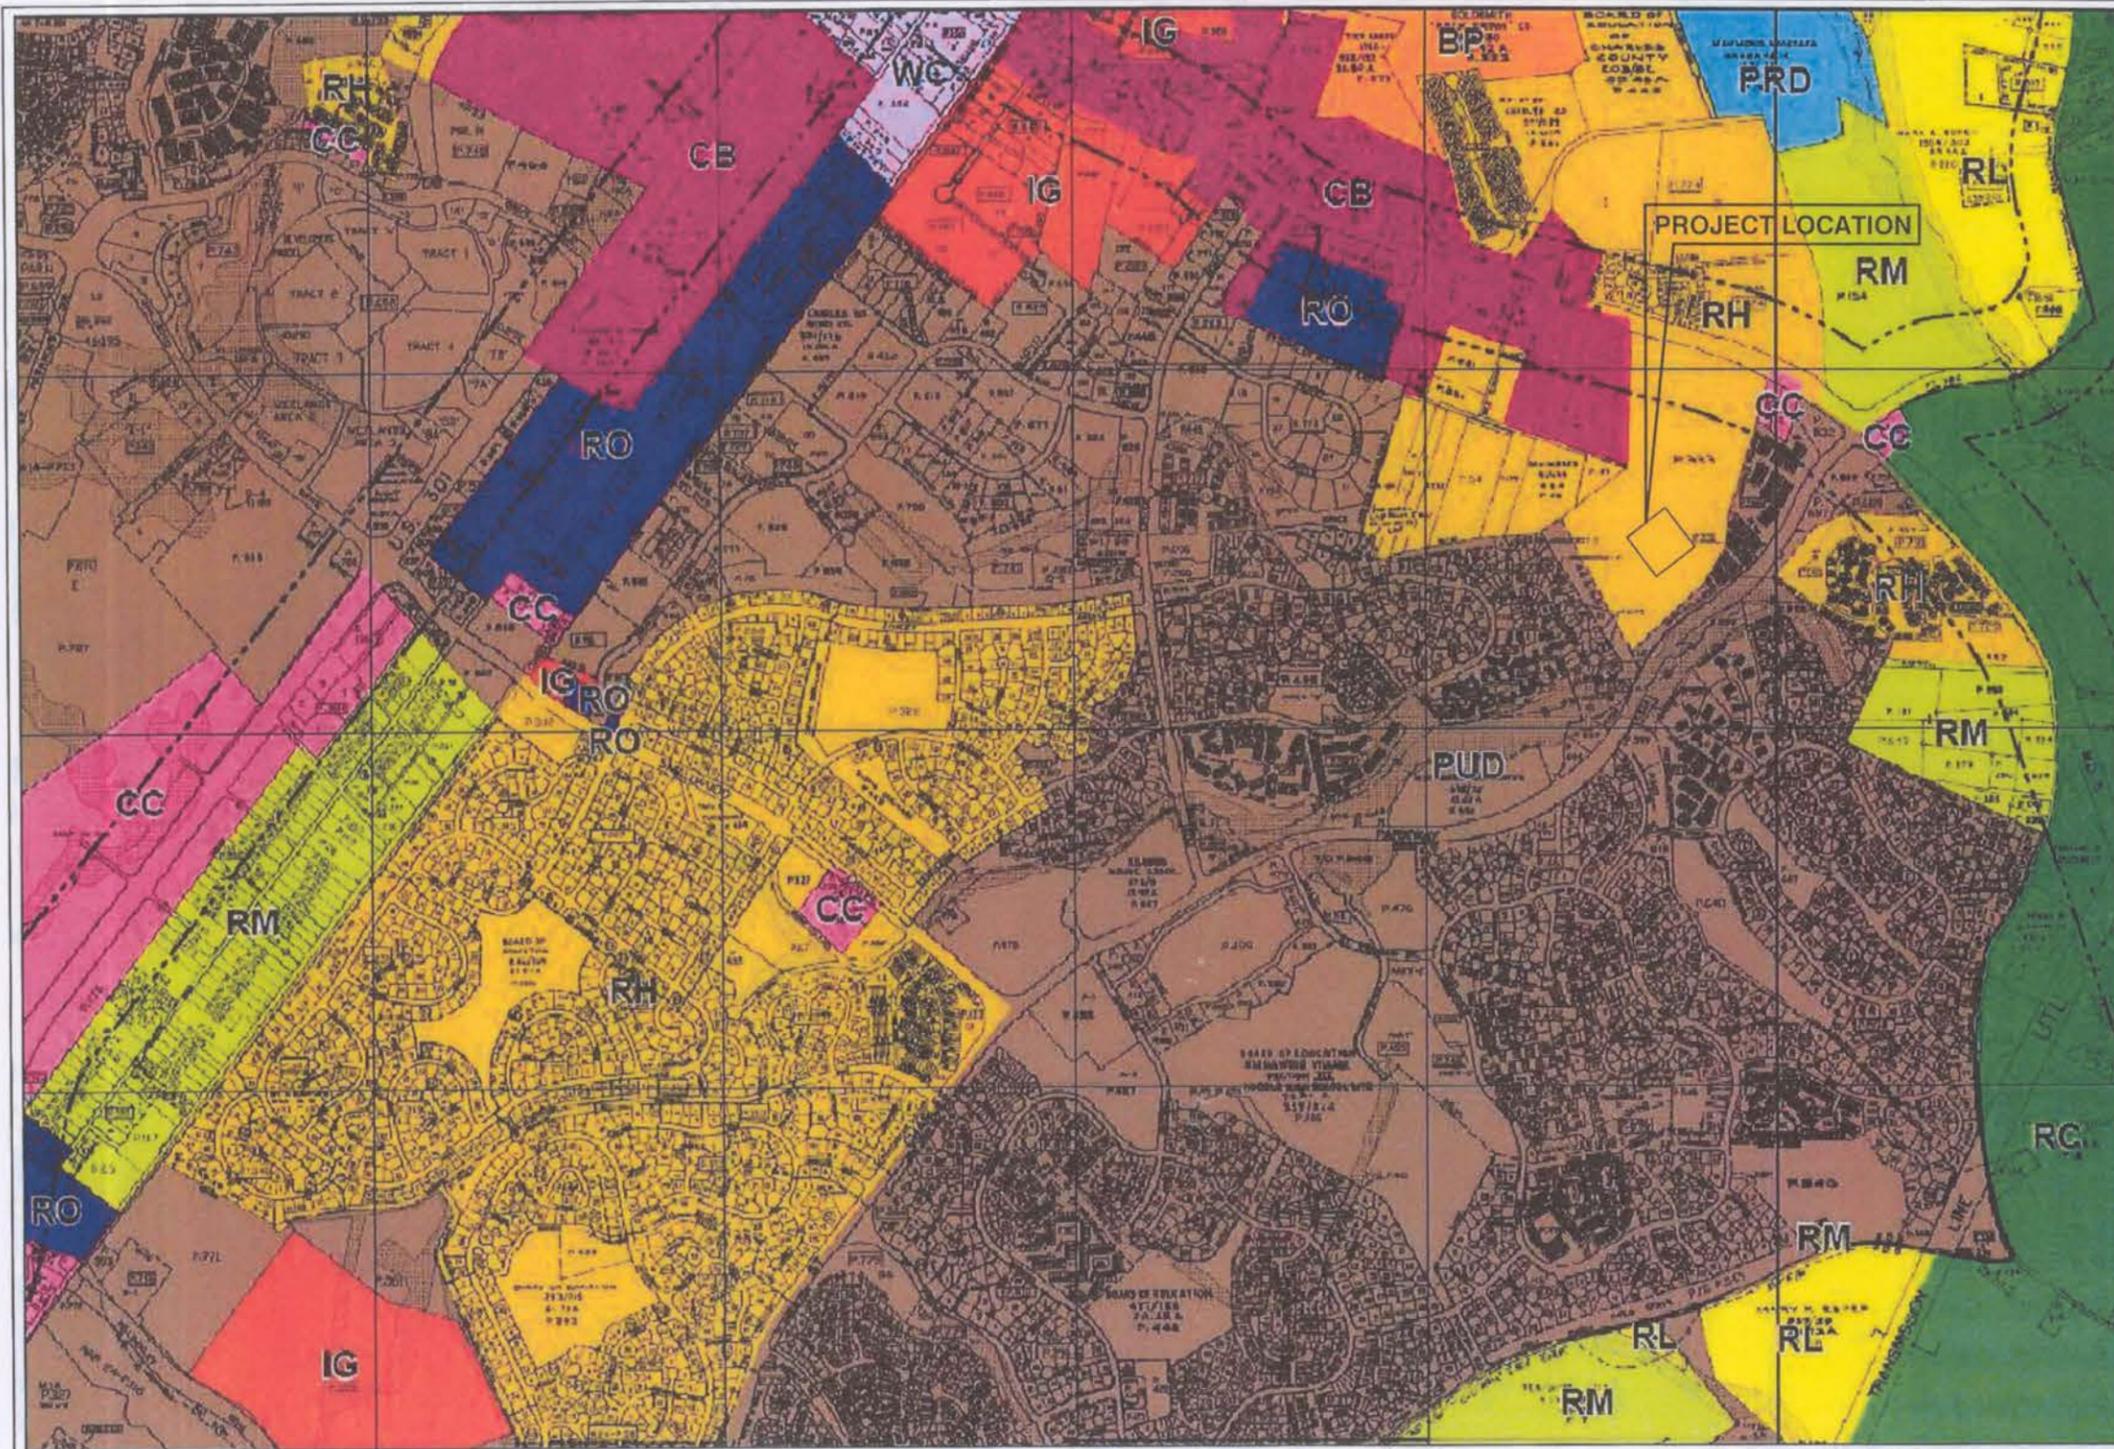

BASE ZONES	
AC	AGRICULTURAL CONSERVATION
RC, RC(D)	RURAL CONSERVATION
RM	RURAL RESIDENTIAL
RV	VILLAGE RESIDENTIAL
RL	LOW DENSITY SUBURBAN RESIDENTIAL
RM	MEDIUM DENSITY SUBURBAN RESIDENTIAL
RH	HIGH DENSITY SUBURBAN RESIDENTIAL
RO	RESIDENTIAL / OFFICE
CER	CORE DEVELOPMENT / RESIDENTIAL
CMR	CORE MIXED RESIDENTIAL
CRR	CORE RETAIL RESIDENTIAL
CN	NEIGHBORHOOD COMMERCIAL
CC	COMMUNITY COMMERCIAL
CB	CENTRAL BUSINESS
VC	VILLAGE COMMERCIAL
BP	BUSINESS PARK
IG	LIGHT INDUSTRIAL
I	HEAVY INDUSTRIAL
AUC	ACTON URBAN CENTER
WC	WALDORF CENTRAL
RO(D)	RURAL CONSERVATION DEFERRED DEVELOPMENT DISTRICT
OVERLAY ZONES	
HC	HIGHWAY CORRIDOR
RP	RESOURCE PROTECTION
CA	CRITICAL AREA BOUNDARY
FLOATING ZONES	
PRD	PLANNED RESIDENTIAL DEVELOPMENT
PMH	PLANNED MOBILE HOME PARK
PEIP	PLANNED EMPLOYMENT/INDUSTRIAL PARK
PMU	PLANNED MIX USE
PUD	PLANNED UNIT DEVELOPMENT
WPC	WATERFRONT PLANNED COMMUNITY
TOD	TRANSIT ORIENTED DEVELOPMENT

PROPERTY LINE	---
SUBDIVISION LINE	---
TOWN BOUNDARY	---
PRIVATE ROAD	---
STREAM LINE	---
CONTRIBUTING OWNERSHIP	---
TAX MAPS: 2008 MD DEPT OF PLANNING	
ZONING: CHARLES COUNTY ZONING REGULATIONS CHAPTER 237	



# ZONING MAP

## CHARLES COUNTY, MARYLAND

DEPARTMENT OF PLANNING AND GROWTH MANAGEMENT



DATE: 4/13/2010  
 REVISION: BILL 2010-03  
 MAP NO. 15

**TECTONIC**  
 PLANNING  
 ENGINEERING  
 SURVEYING  
 CONSTRUCTION MANAGEMENT  
 TECTONIC Engineering & Surveying Consultants P.C.  
 8639 Mayland Drive, Suite 102  
 Richmond, VA 23294  
 Phone: (804) 217-8504  
 Fax: (804) 270-0593  
 www.tectonicengineering.com

**HEATHCOTE**  
 CROWN 881050  
 10103463-3227  
 3785 LEONARDTOWN ROAD  
 WALDORF, MD 20602


AT&T MOBILITY CORP.  
 7150 STANDARD DRIVE  
 HANOVER, MD 21076

NO.	DATE	REVISIONS	BY	CHK	APP'D
0	4/8/14	PER COMMENTS	CAL	PSM	PSM
C	11/13/13	REVISED ACCESS ROAD	JDD	PSM	PSM
B	10/29/13	SURVEY ADDED	JDD	PSM	PSM
A	10/15/13	FOR REVIEW	JDD	PSM	PSM

SCALE: AS SHOWN    DESIGNED BY: PSM    DRAWN BY: CAL



ZONING MAP		
PROJECT NUMBER: 10103463-3227		
JOB NUMBER	DRAWING NUMBER	REV
6620.HEATHCOTE	C1	0

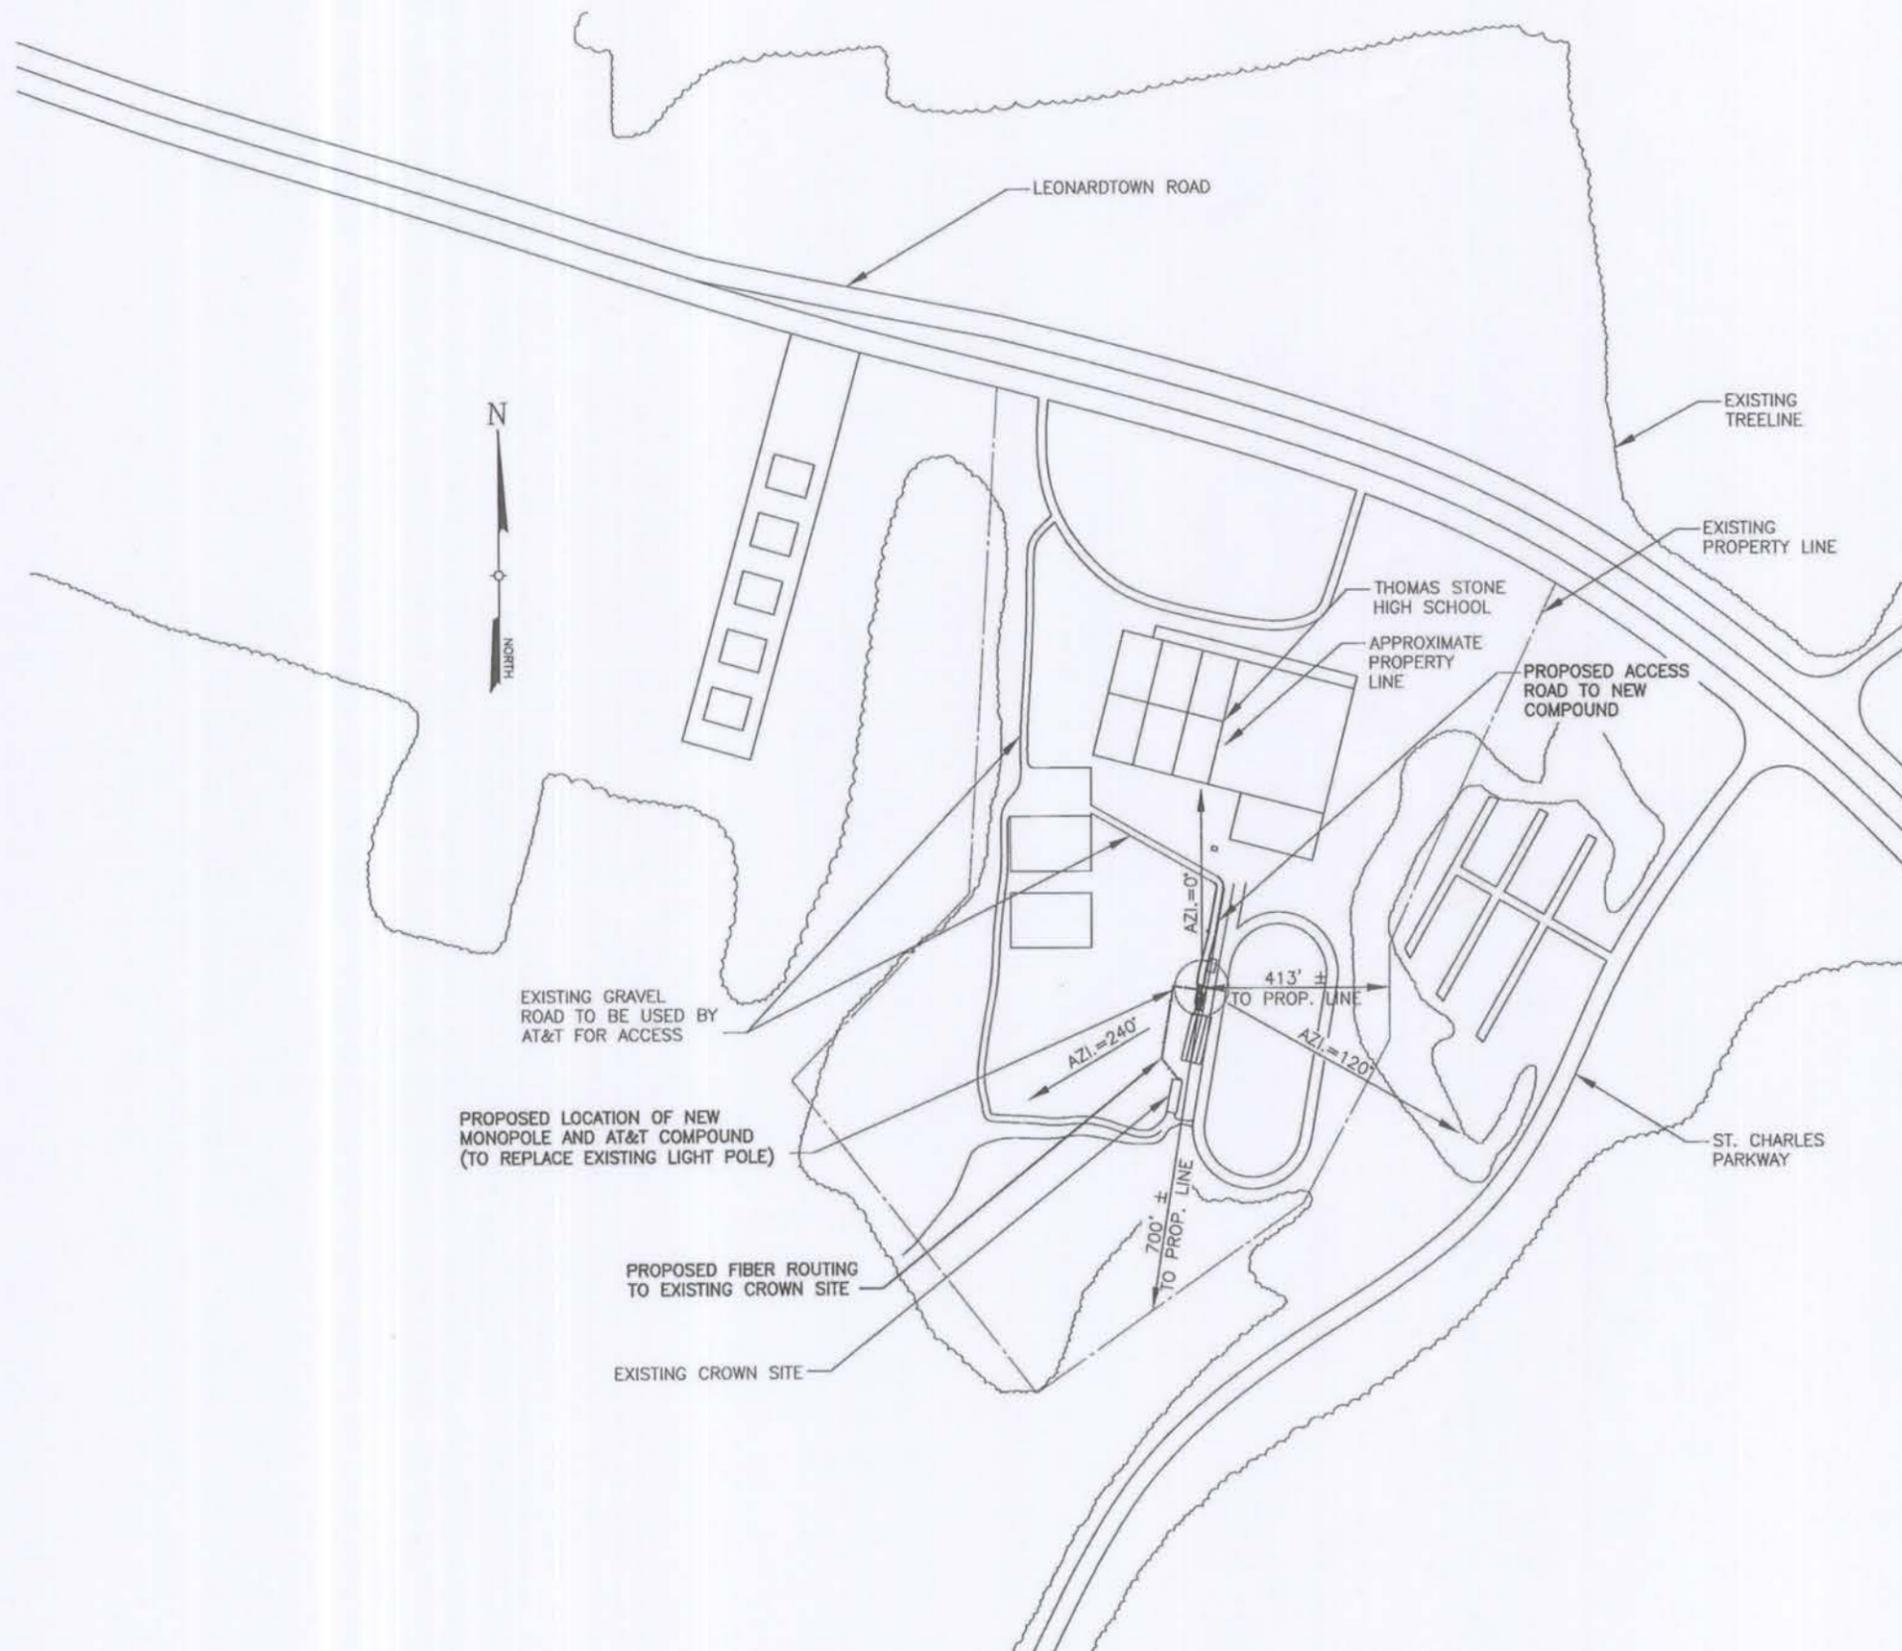

LEGEND	
	EXISTING FACILITIES
	PROPOSED FACILITIES
	EXISTING PROPERTY LINE

1  
C2 BOUNDARY SITE PLAN  
SCALE: 1" = 200'

**TECTONIC**

PLANNING  
ENGINEERING  
SURVEYING  
CONSTRUCTION MANAGEMENT

TECTONIC Engineering & Surveying Consultants P.C.  
8839 Mayland Drive, Suite 102  
Richmond, VA 23294

Phone: (804) 217-8504  
Fax: (804) 270-0593  
www.tectonicengineering.com

HEATHCOTE  
CROWN 881050  
10103463-3227  
3785 LEONARDTOWN ROAD  
WALDORF, MD 20602



**at&t**  
Mobility


AT&T MOBILITY CORP.  
7150 STANDARD DRIVE  
HANOVER, MD 21076

NO.	DATE	REVISIONS	BY	CHK	APP'D
0	4/8/14	PER COMMENTS	CAL	PSM	PSM
C	11/13/13	REVISED ACCESS ROAD	JDD	PSM	PSM
B	10/29/13	SURVEY ADDED	JDD	PSM	PSM
A	10/15/13	FOR REVIEW	JDD	PSM	PSM

SCALE: AS SHOWN    DESIGNED BY: PSM    DRAWN BY: CAL



BOUNDARY SITE PLAN		
PROJECT NUMBER: 10103463-3227		
JOB NUMBER	DRAWING NUMBER	REV
6620.HEATHCOTE	C2	0

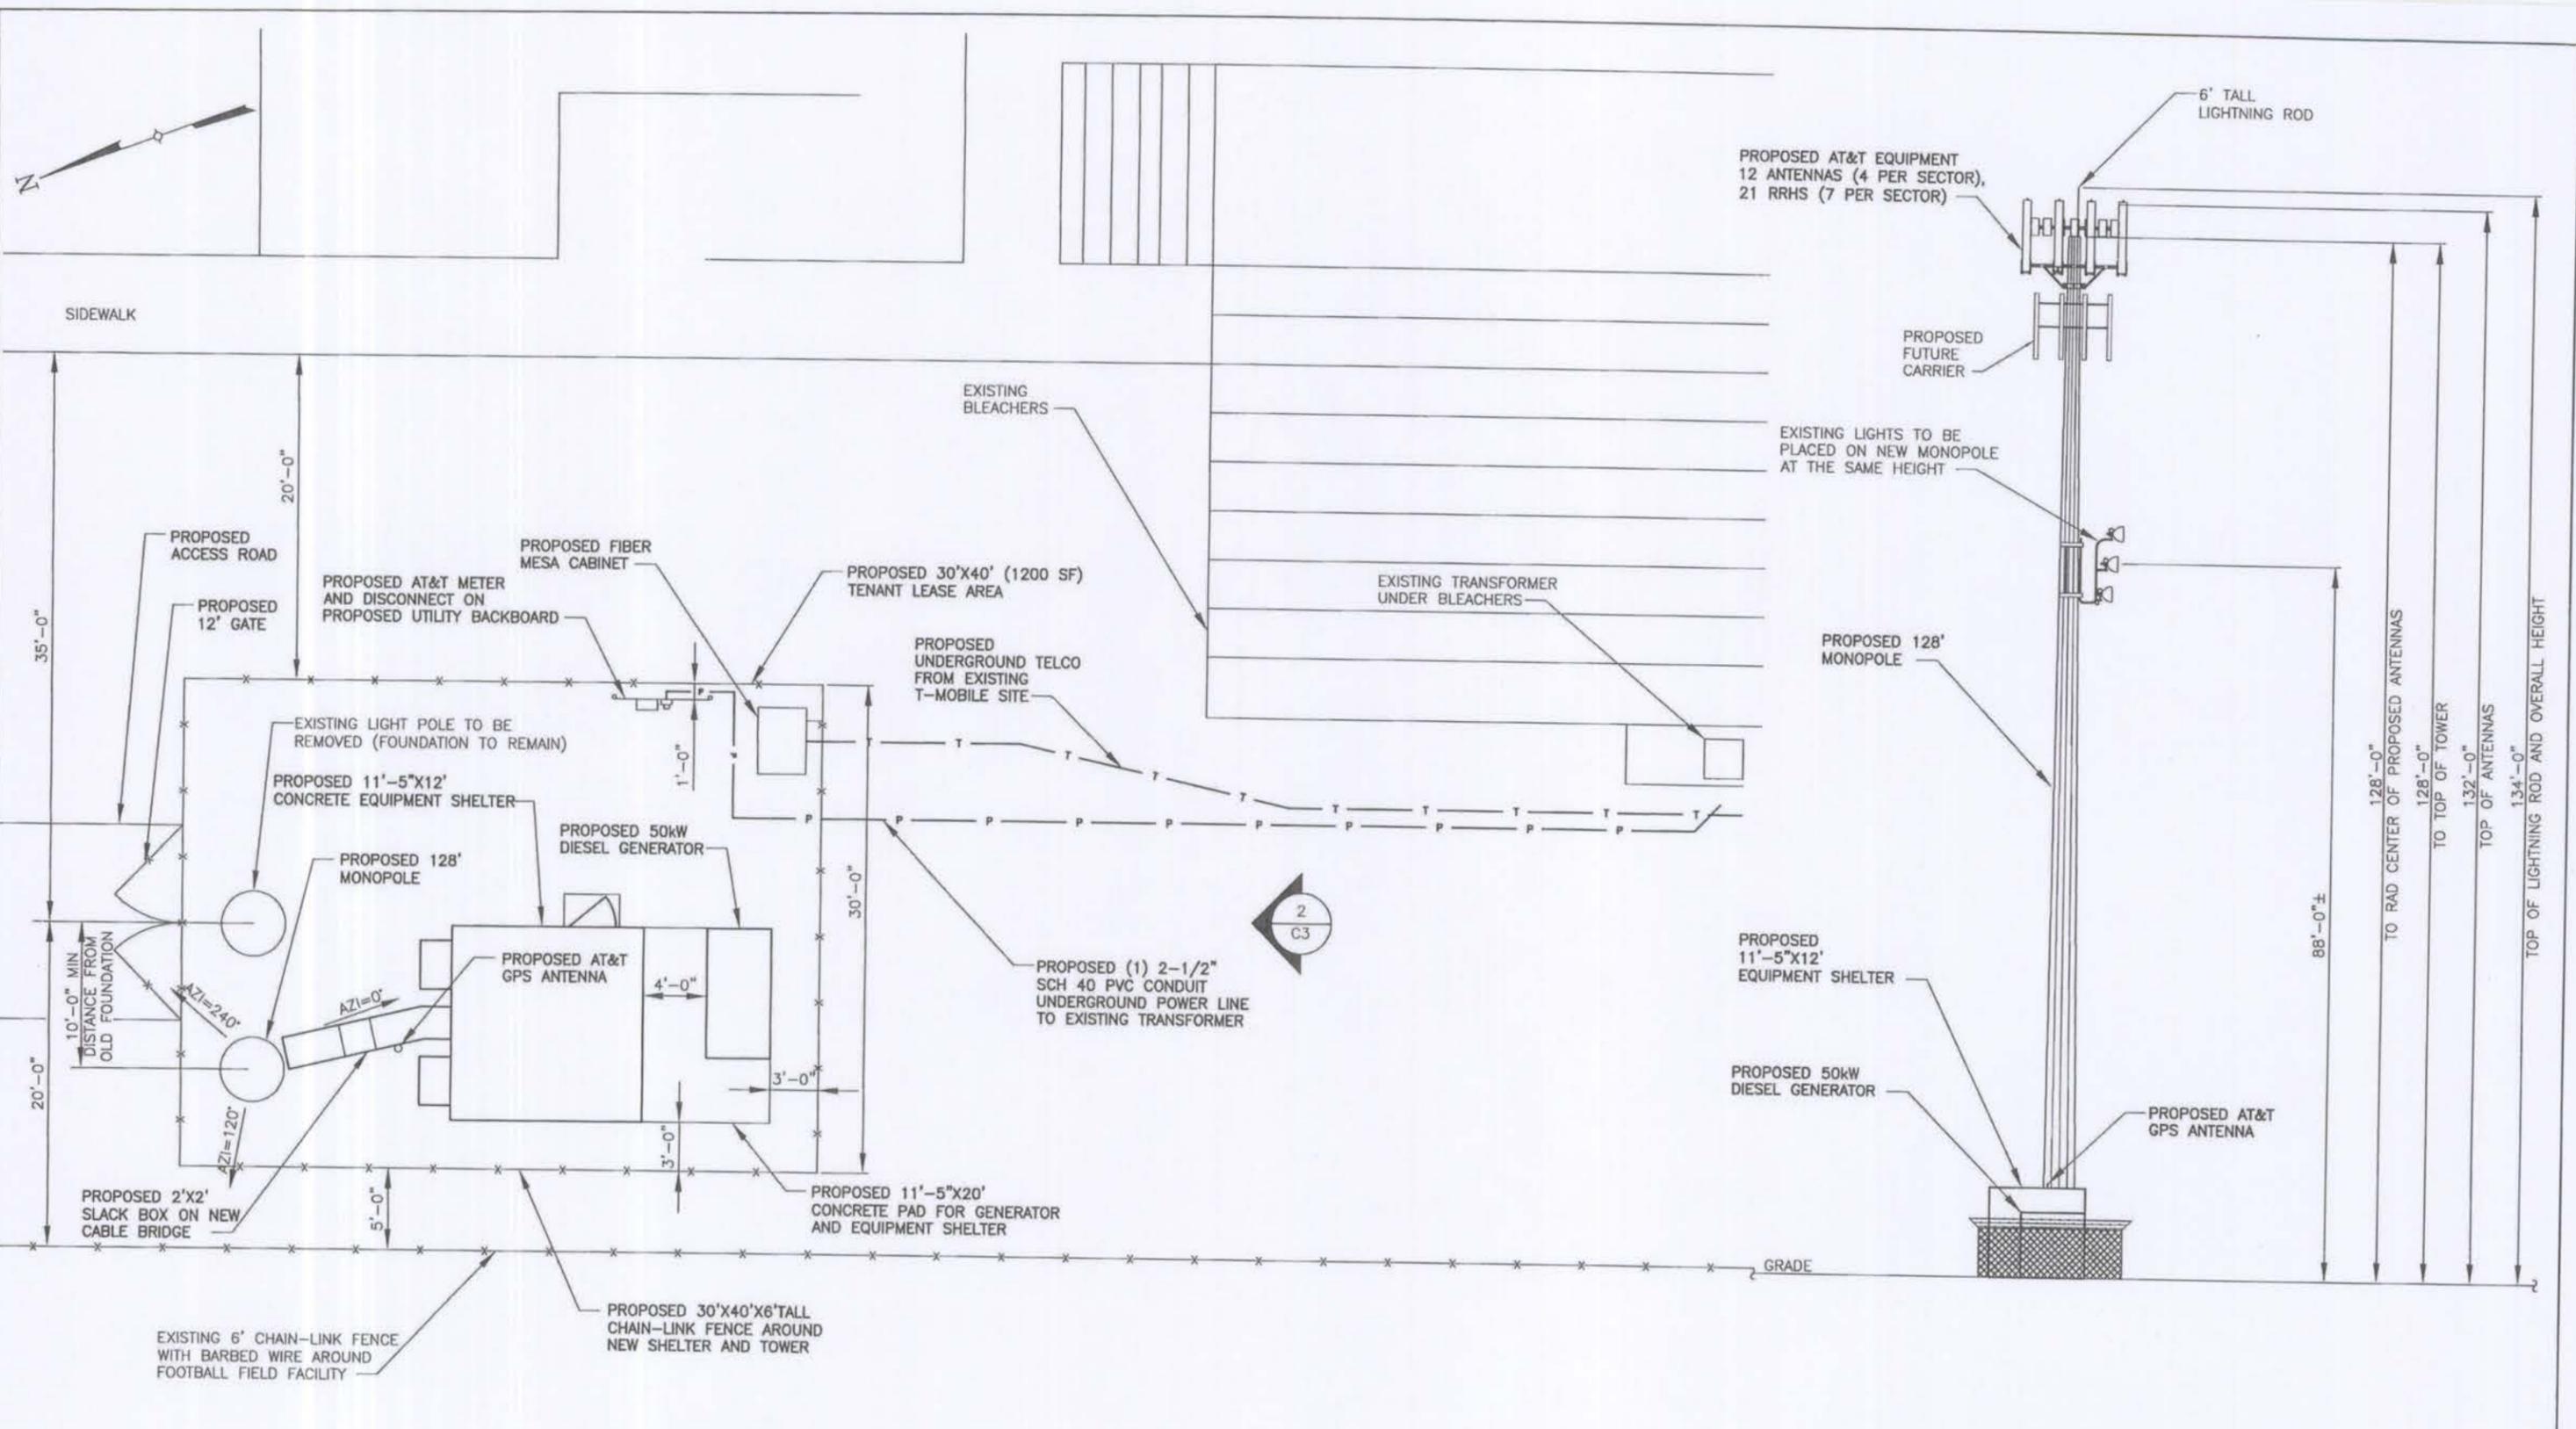

1 COMPOUND LAYOUT  
C3 SCALE: 1" = 5'

2 ELEVATION VIEW  
C3 NOT TO SCALE

**TECTONIC**  
PLANNING  
ENGINEERING  
SURVEYING  
CONSTRUCTION  
MANAGEMENT  
TECTONIC Engineering & Surveying Consultants P.C.  
8639 Mayland Drive, Suite 102  
Richmond, VA 23284  
Phone: (804) 217-8504  
Fax: (804) 270-0593  
www.tectonicengineering.com


**HEATHCOTE**  
CROWN 881050  
10103463-3227  
3785 LEONARDTOWN ROAD  
WALDORF, MD 20602

**at&t** MOBILITY  
AT&T MOBILITY CORP.  
7150 STANDARD DRIVE  
HANOVER, MD 21076

0	4/8/14	PER COMMENTS	CAL	PSM	PSM
C	11/13/13	REVISED ACCESS ROAD	JDD	PSM	PSM
B	10/28/13	SURVEY ADDED	JDD	PSM	PSM
A	10/15/13	FOR REVIEW	JDD	PSM	PSM
NO.	DATE	REVISIONS	BY	CHK	APP'D
SCALE: AS SHOWN			DESIGNED BY: PSM	DRAWN BY: CAL	




COMPOUND LAYOUT AND ELEVATION VIEW		
PROJECT NUMBER: 10103463-3227		
JOB NUMBER	DRAWING NUMBER	REV
6620.HEATHCOTE	C3	0

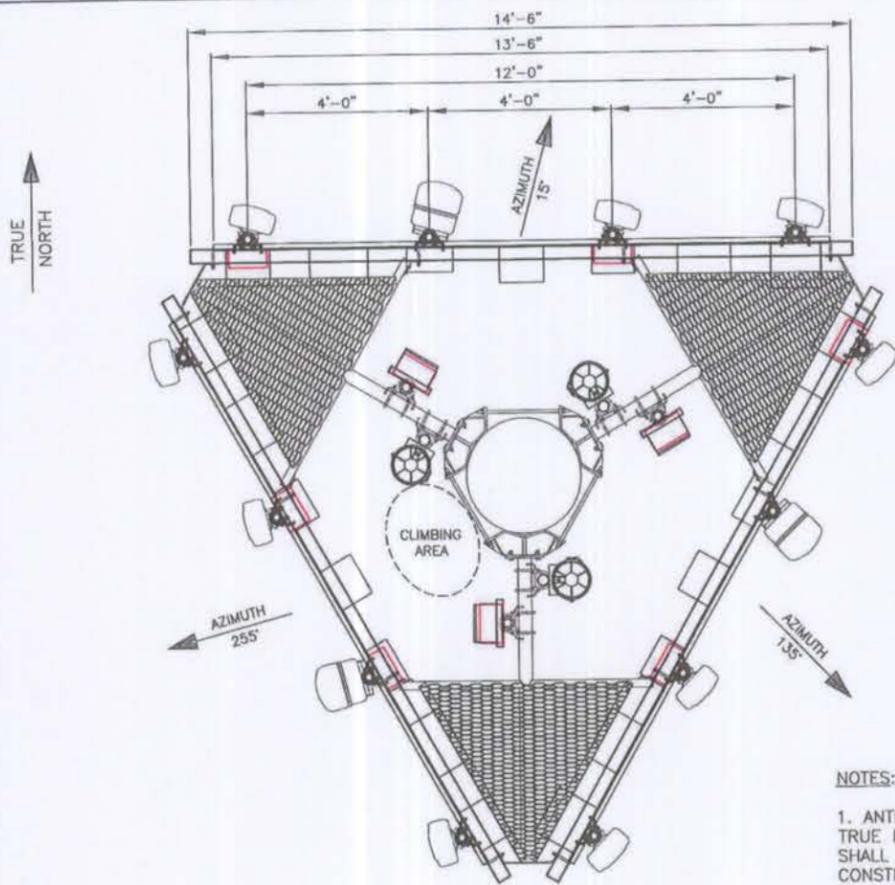

**NOTES:**


1. ANTENNA ORIENTATION IS BASED ON TRUE NORTH BEARING, CONTRACTOR SHALL VERIFY TRUE NORTH PRIOR TO CONSTRUCTION.
2. CONTRACTOR TO REFER TO FINAL RF CONFIGURATIONS SHEET FOR ANTENNA AZIMUTHS PRIOR TO CONSTRUCTION.

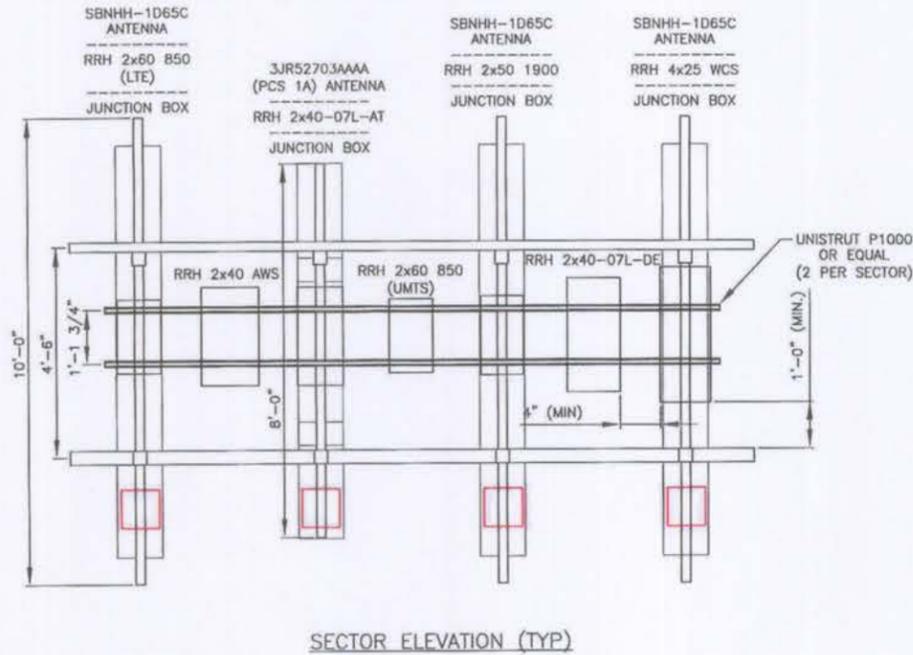


SECTOR ELEVATION (TYP)

**ANTENNA SPECIFICATIONS**

MODEL	LENGTH (IN)	WIDTH (IN)	DEPTH (IN)	QUANTITY
COMMSCOPE SBNHH-1D65C	96	11.9	7.1	9
ANTEL/LUCENT 3JR52703AAAA	96.4	11.9	12.6	3

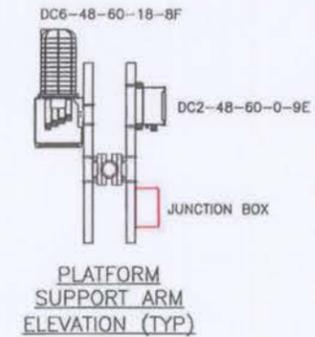



PLATFORM SUPPORT ARM ELEVATION (TYP)

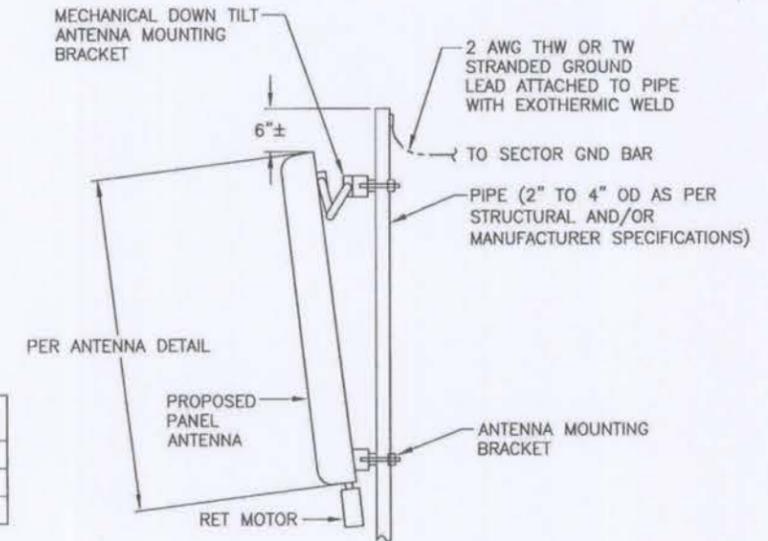


ANTENNA MOUNTING DETAIL

1 ANTENNA MOUNTING AND ORIENTATION DETAIL  
C4 NTS

DETAIL 1520  
NTS C4

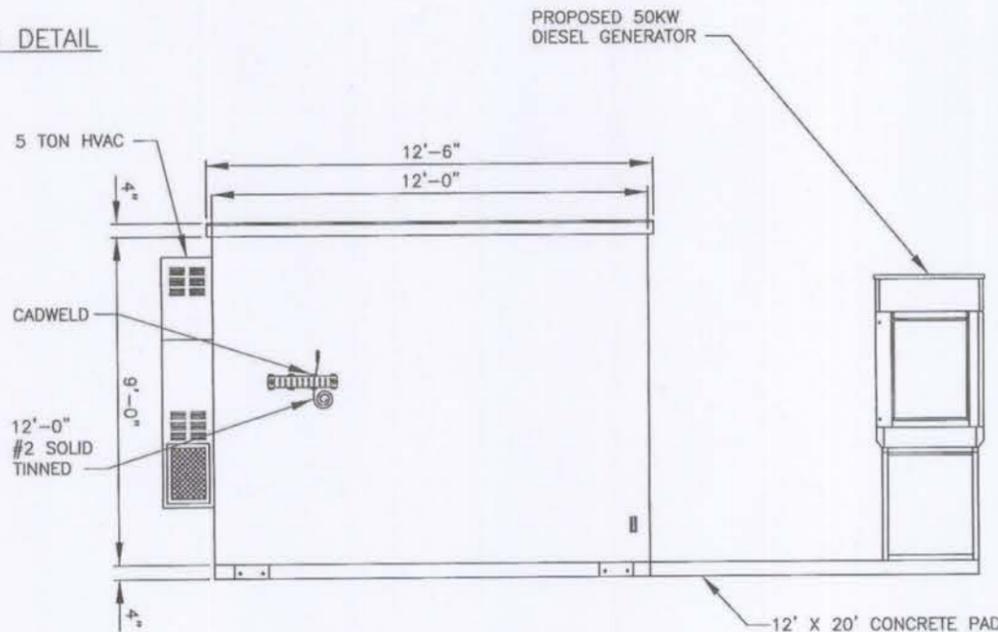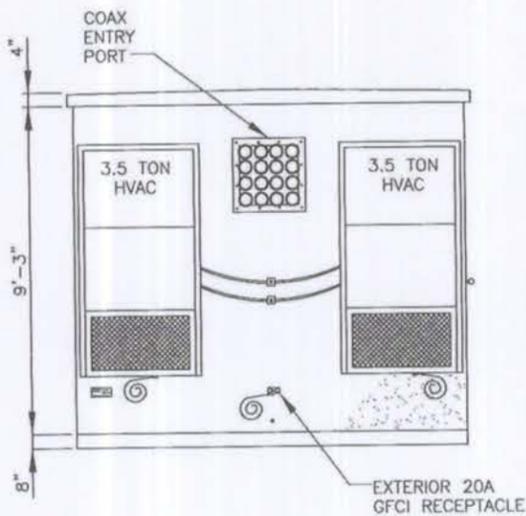

3 EQUIPMENT SHELTER ELEVATIONS  
C4 NTS

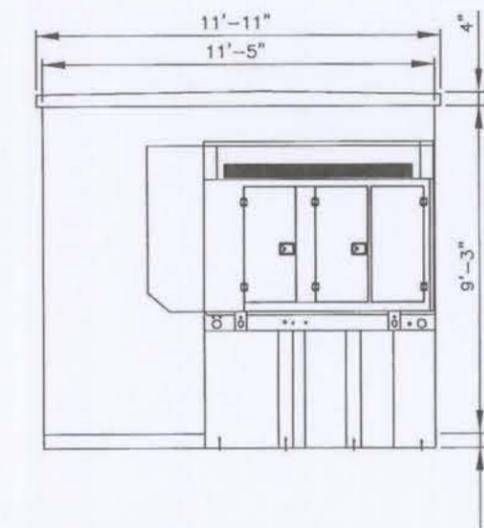

**NOTE:**

GROUND BAR AND CANOPY ARE SHIPPED LOOSE WITH THE SHELTER (INSTALLED BY GC)

**TECTONIC**

TECTONIC Engineering & Surveying Consultants P.C.  
8639 Mayland Drive, Suite 102  
Richmond, VA 23294  
Phone: (804) 217-8504  
Fax: (804) 270-0593  
www.tectonicengineering.com

HEATHCOTE  
CROWN 881050  
10103463-3227  
3785 LEONARDTOWN ROAD  
WALDORF, MD 20602

**at&t** Mobility  
AT&T MOBILITY CORP.  
7150 STANDARD DRIVE  
HANOVER, MD 21076

NO.	DATE	REVISIONS	BY	CHK	APP'D
D	4/8/14	PER COMMENTS	CAL	PSM	PSM
C	11/13/13	REVISED ACCESS ROAD	JDD	PSM	PSM
B	10/29/13	SURVEY ADDED	JDD	PSM	PSM
A	10/15/13	FOR REVIEW	JDD	PSM	PSM




CONSTRUCTION DETAILS


PROJECT NUMBER: 10103463-3227

JOB NUMBER	DRAWING NUMBER	REV
6620.HEATHCOTE	C4	0

0J2534-ATT

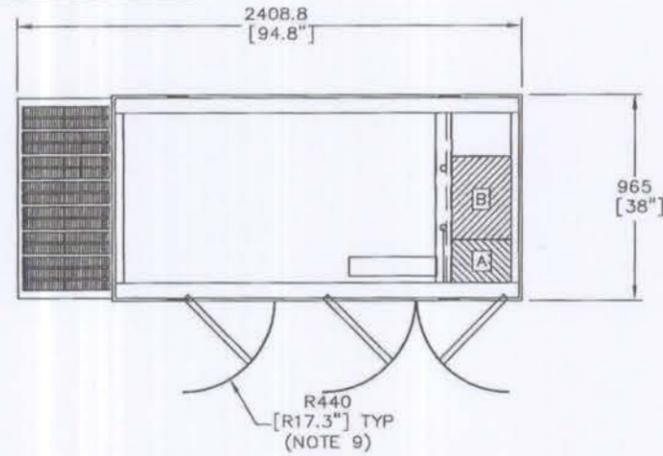

TOP VIEW

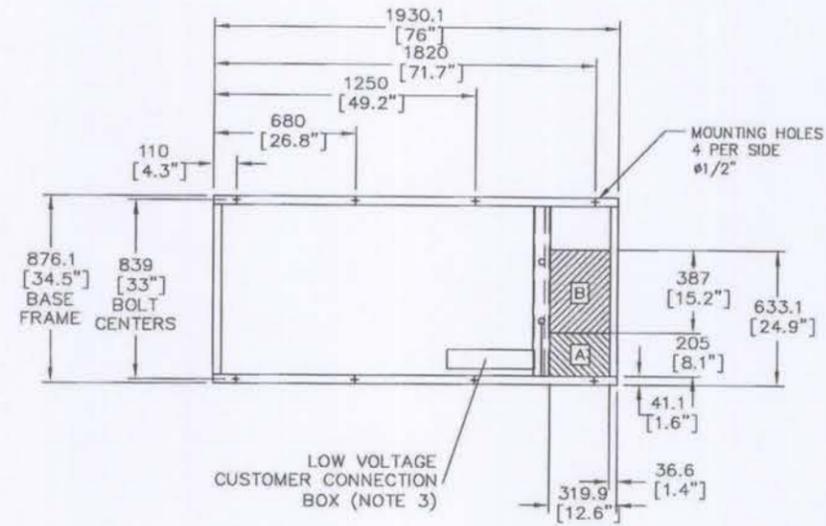


BOTTOM VIEW PAD LAYOUT


RECOMMENDED ELECTRICAL STUB-UPS (SEE TOP VIEW)	
DESCRIPTION	INSIDE BASE
AC LOAD LEAD CONDUIT GLAND AREA	A
1) LOW VOLTAGE CUSTOMER CONNECTION BOX FOR 120VAC GFCI OUTLET, (STANDARD BLOCK HEATER, BATTERY CHARGER AND OTHER 120 VAC OPTIONS).	B SEE NOTE 3
2) TRANSFER SWITCH/ COMMUNICATIONS CONDUITS. COMMUNICATIONS AND 2-WIRE START MUST NOT BE RUN IN CONDUIT WITH AC WIRING.	

NOTES:


1. THE LEFT SIDE OF THE GENERATOR IS SERVICE ACCESSIBLE.
2. 10 AMP BATTERY CHARGER ENCLOSED WITHIN CONTROL PANEL.
3. CONNECTION POINTS FOR CONTROL WIRES. BOTTOM OF LOW VOLTAGE CUSTOMER CONNECTION BOX HAS KNOCKOUTS FOR 1/2" AND 3/4" CONDUIT FITTINGS.
4. GENERATOR MUST BE GROUNDED.
5. 12 VOLT NEGATIVE GROUND SYSTEM.
6. OPTIONAL REMOTE EMERGENCY STOP SHIPPED LOOSE WITH GENERATOR.
7. MAIN LINE CIRCUIT BREAKER (MLCB), AC LOAD LEAD CONNECTION AND AUXILIARY 120/240V CONNECTION.
8. LEVEL 2A SOUND ATTENUATED ENCLOSURE STANDARD WITH GENERATOR.
9. DOORS MUST BE ABLE TO OPEN 90 DEG. TO BE REMOVED. DOORS ARE LOCATED ON THE LEFT SIDE OF THE GENERATOR ONLY.
10. STUB-UPS: BASE TANK REQUIRES ALL STUB-UPS TO BE IN THE REAR TANK STUB-UP AREA.
11. 'A' IS THE STUB UP AREA FOR THE MLCB AND NEUTRAL CONNECTION.
12. SEE DRAWING OC3850 FOR DUCT REMOVAL. REMOVAL OF FRONT DUCT WILL PROVIDE ACCESS TO MUFFLER.
13. 120VAC ENGINE BLOCK HEATER.
14. 210 GALLON USEABLE CAPACITY BASE TANK STANDARD WITH GENERATOR.
15. MUST ALLOW FREE FLOW OF DISCHARGE AIR AND EXHAUST. SEE SPEC SHEET FOR MINIMUM AIR FLOW AND MAXIMUM RESTRICTION REQUIREMENTS.
16. MUST ALLOW FREE FLOW OF INTAKE AIR. SEE SPEC SHEET FOR MINIMUM AIR FLOW AND MAXIMUM RESTRICTION REQUIREMENTS.
17. IT IS THE RESPONSIBILITY OF THE INSTALLATION TECHNICIAN TO ENSURE THAT THE GENERATOR INSTALLATION COMPLIES WITH ALL APPLICABLE CODES, STANDARDS, AND REGULATIONS.

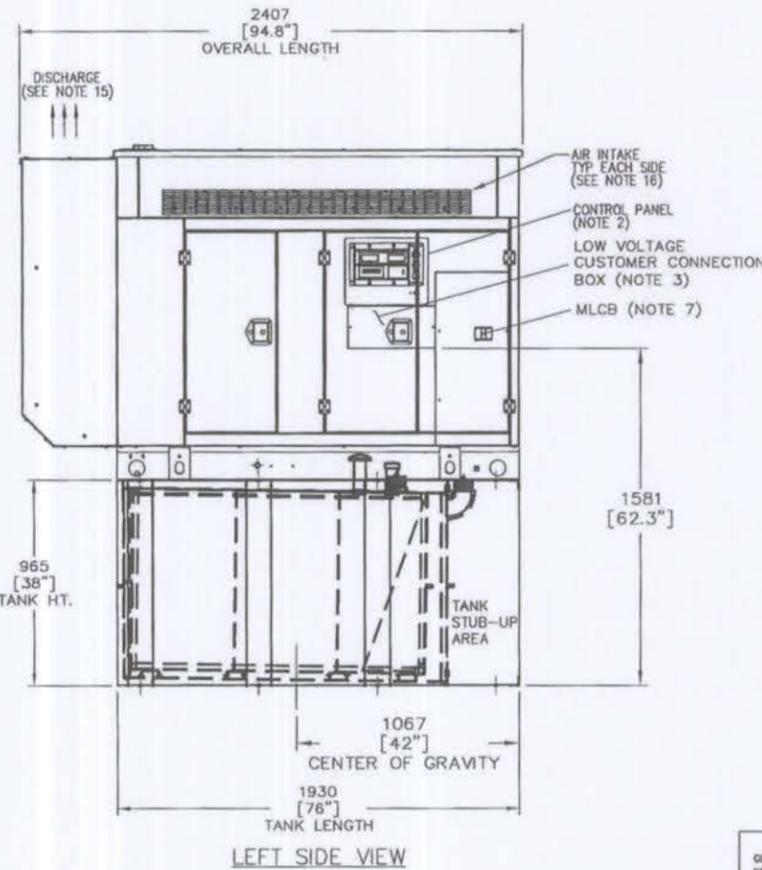

LEFT SIDE VIEW

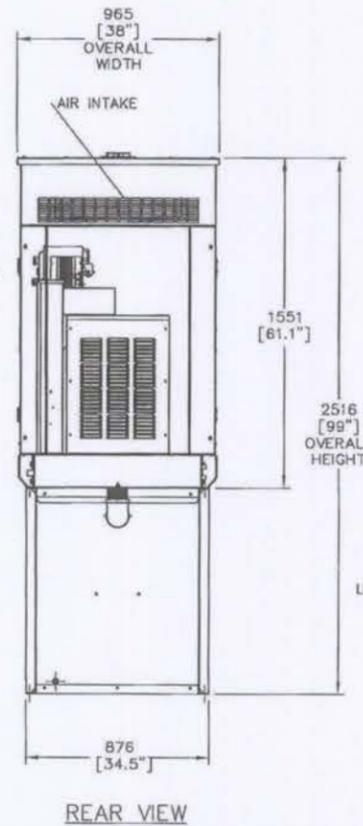

REAR VIEW

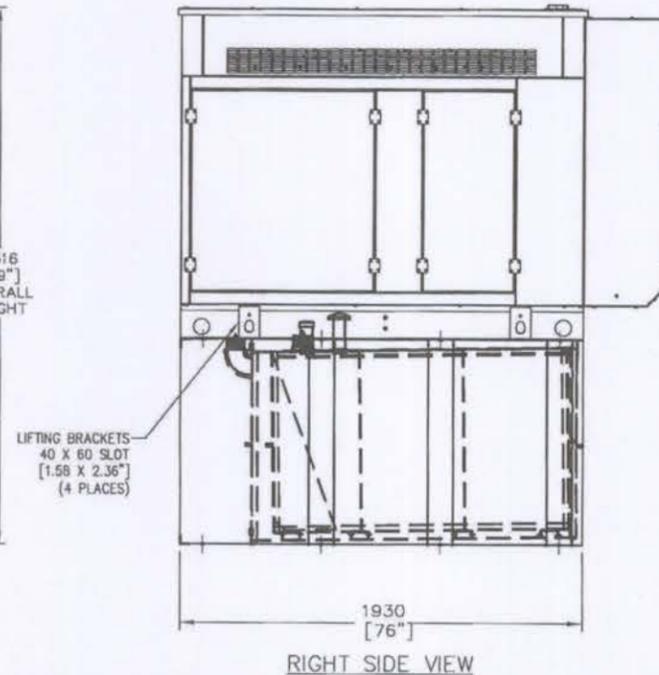

RIGHT SIDE VIEW

WEIGHT DATA (INCLUDES WOODEN SHIPPING SKID)  
ENCLOSED GENERATOR WITH EMPTY FUEL TANK - 1700kg (3750 lbs)

UNITS: mm [INCHES]

GENERAC POWER SYSTEMS OWNS THE COPYRIGHT OF THIS DRAWING WHICH IS SUPPLIED IN CONFIDENCE AND MUST NOT BE USED FOR ANY PURPOSE OTHER THAN FOR WHICH IT IS SUPPLIED WITHOUT THE EXPRESS WRITTEN CONSENT OF GENERAC POWER SYSTEMS.

© GENERAC POWER SYSTEMS 2001

INSTALLATION D4.5L G17 50KW  
ENCLOSED LEVEL 2A

**GENERAC POWER SYSTEMS**  
Waukesha  
P.O. BOX 8  
WAUKESHA, WIS. 53187

FILE NAME	0J2534-ATT.DWG	SIZE	B
SCALE	NTS	FIRST USE	0060720
DWG NO.	0J2534-ATT	REV	A

INSTALLATION DRAWING

**TECTONIC**

TECTONIC Engineering & Surveying Consultants P.C.  
8639 Mayland Drive, Suite 102  
Richmond, VA 23294

Phone: (804) 217-8504  
Fax: (804) 270-0593  
www.tectonicengineering.com

**HEATHCOTE**  
CROWN 881050  
10103463-3227  
3785 LEONARDTOWN ROAD  
WALDORF, MD 20602



**at&t**  
Mobility  
AT&T MOBILITY CORP.  
7150 STANDARD DRIVE  
HANOVER, MD 21076

NO.	DATE	REVISIONS	BY	CHK	APP'D
D	4/8/14	PER COMMENTS	JDD	PSM	PSM
C	11/13/13	REVISED ACCESS ROAD	JDD	PSM	PSM
B	10/29/13	SURVEY ADDED	JDD	PSM	PSM
A	10/15/13	FOR REVIEW	JDD	PSM	PSM

SCALE: AS SHOWN    DESIGNED BY: PSM    DRAWN BY: CAL



GENERATOR DETAILS

PROJECT NUMBER: 10103463-3227

JOB NUMBER	DRAWING NUMBER	REV
6620.HEATHCOTE	C5	0